


### WATER AND SANITATION DEVELOPMENT PROJECT

### IMPROVEMENT OF COMMUNAL ONSITE SANITATION FACILITIES FOR WAJIR PROJECT AREA

## **VOLUME III:- DRAWINGS**

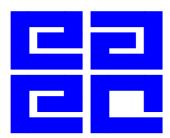


East African Engineering Consultants Ltd. Lenana Court, New Wing No. 3 Lenana Road P. O. Box 30707, 00100 Nairobi, Kenya Tel: (+254)-20-2714514/5/6 (+254) - 20 - 2527995 / 2718861 Email: eaecgroup@gmail.com, info@eaecgroup.com

www.eaecgroup.com




Systel Engineering Limited 5th Floor, Wing II, CIC Plaza, Mara Road, Upperhill, P.O Box 19109-00100, Nairobi, Kenya Tel: + 254(0) 791 329 980 / 726 039 006 Email:consulting@systelengineering.com



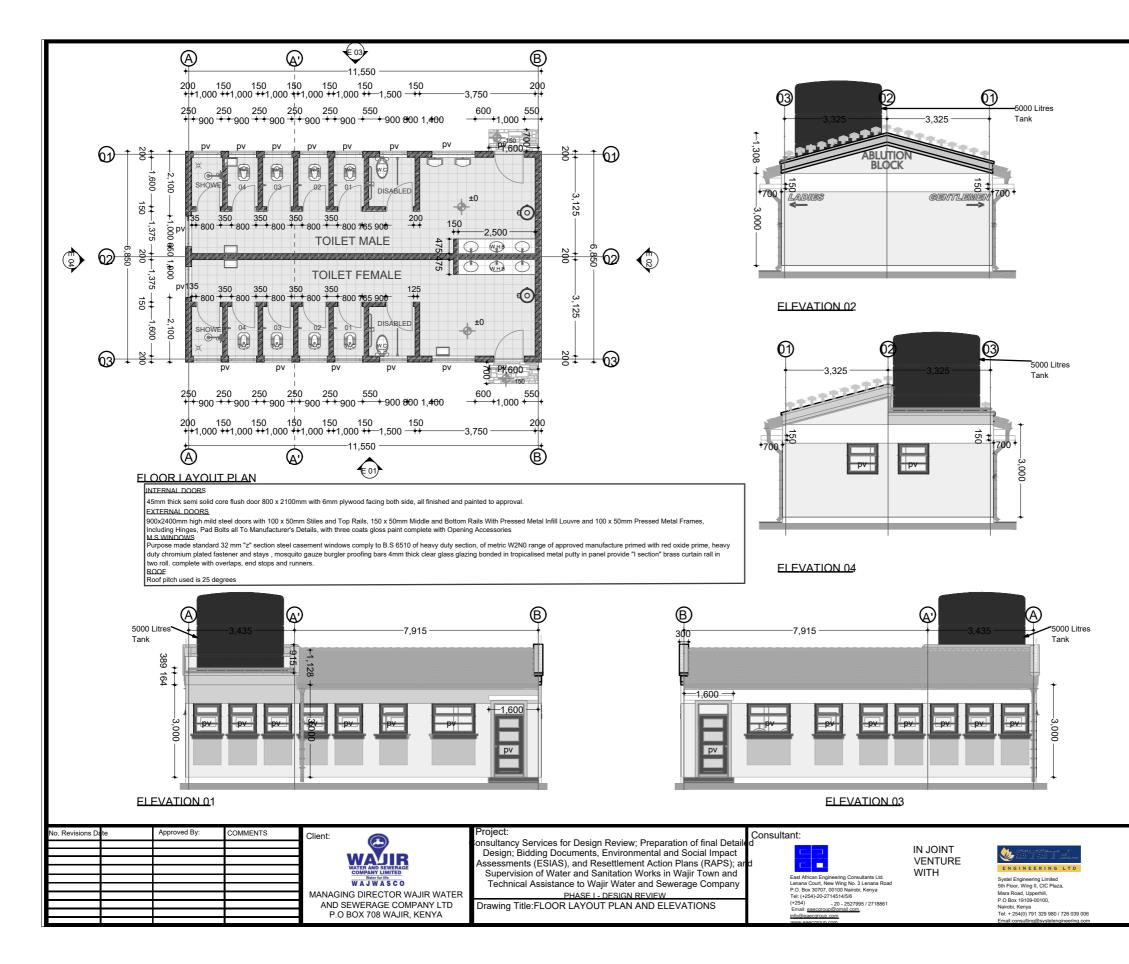

NOTES:			
1. All mea	surements a	re in met	res.
2. All heights are orthometric.			
3. Contou	r interval is 0	.25m	
4. Total A	rea - 12.291	na (30.37	2acres) approx.
		Surv	ey Projection
Projection	UTM		
Datum	WGS 8	34	
Zone	37° N	ORTH	
LEGEND	):		
1. Major	Contour	/	$\left( \right)$
2. Minor	Contour		Ń
3. Spot H	leight+ Value	• •2 <sup>19.</sup>	A
4. Acces	s		
5. Canal			_
6. Buildir	ng		
7. Tree		$(\mathbb{D})$	
8. Fence	-		
9. Contro	ol Point	W1	
10. Wall	•	$\checkmark$	
11. Mant	nole	МН	7
DESIGNED	BY: AMM	DRAW	N BY: AMM
CHECKED	BY: AM	APPRO	VED BY: DNS
SCALE: 1:5	i00 (A1)	DATE:	December2022
JOB No. C7	79	SHE	ET 1 OF 1
DRAWING WFSTP/SW	No. //WRS/1.0/1	Re A	B C D E F H I J K L

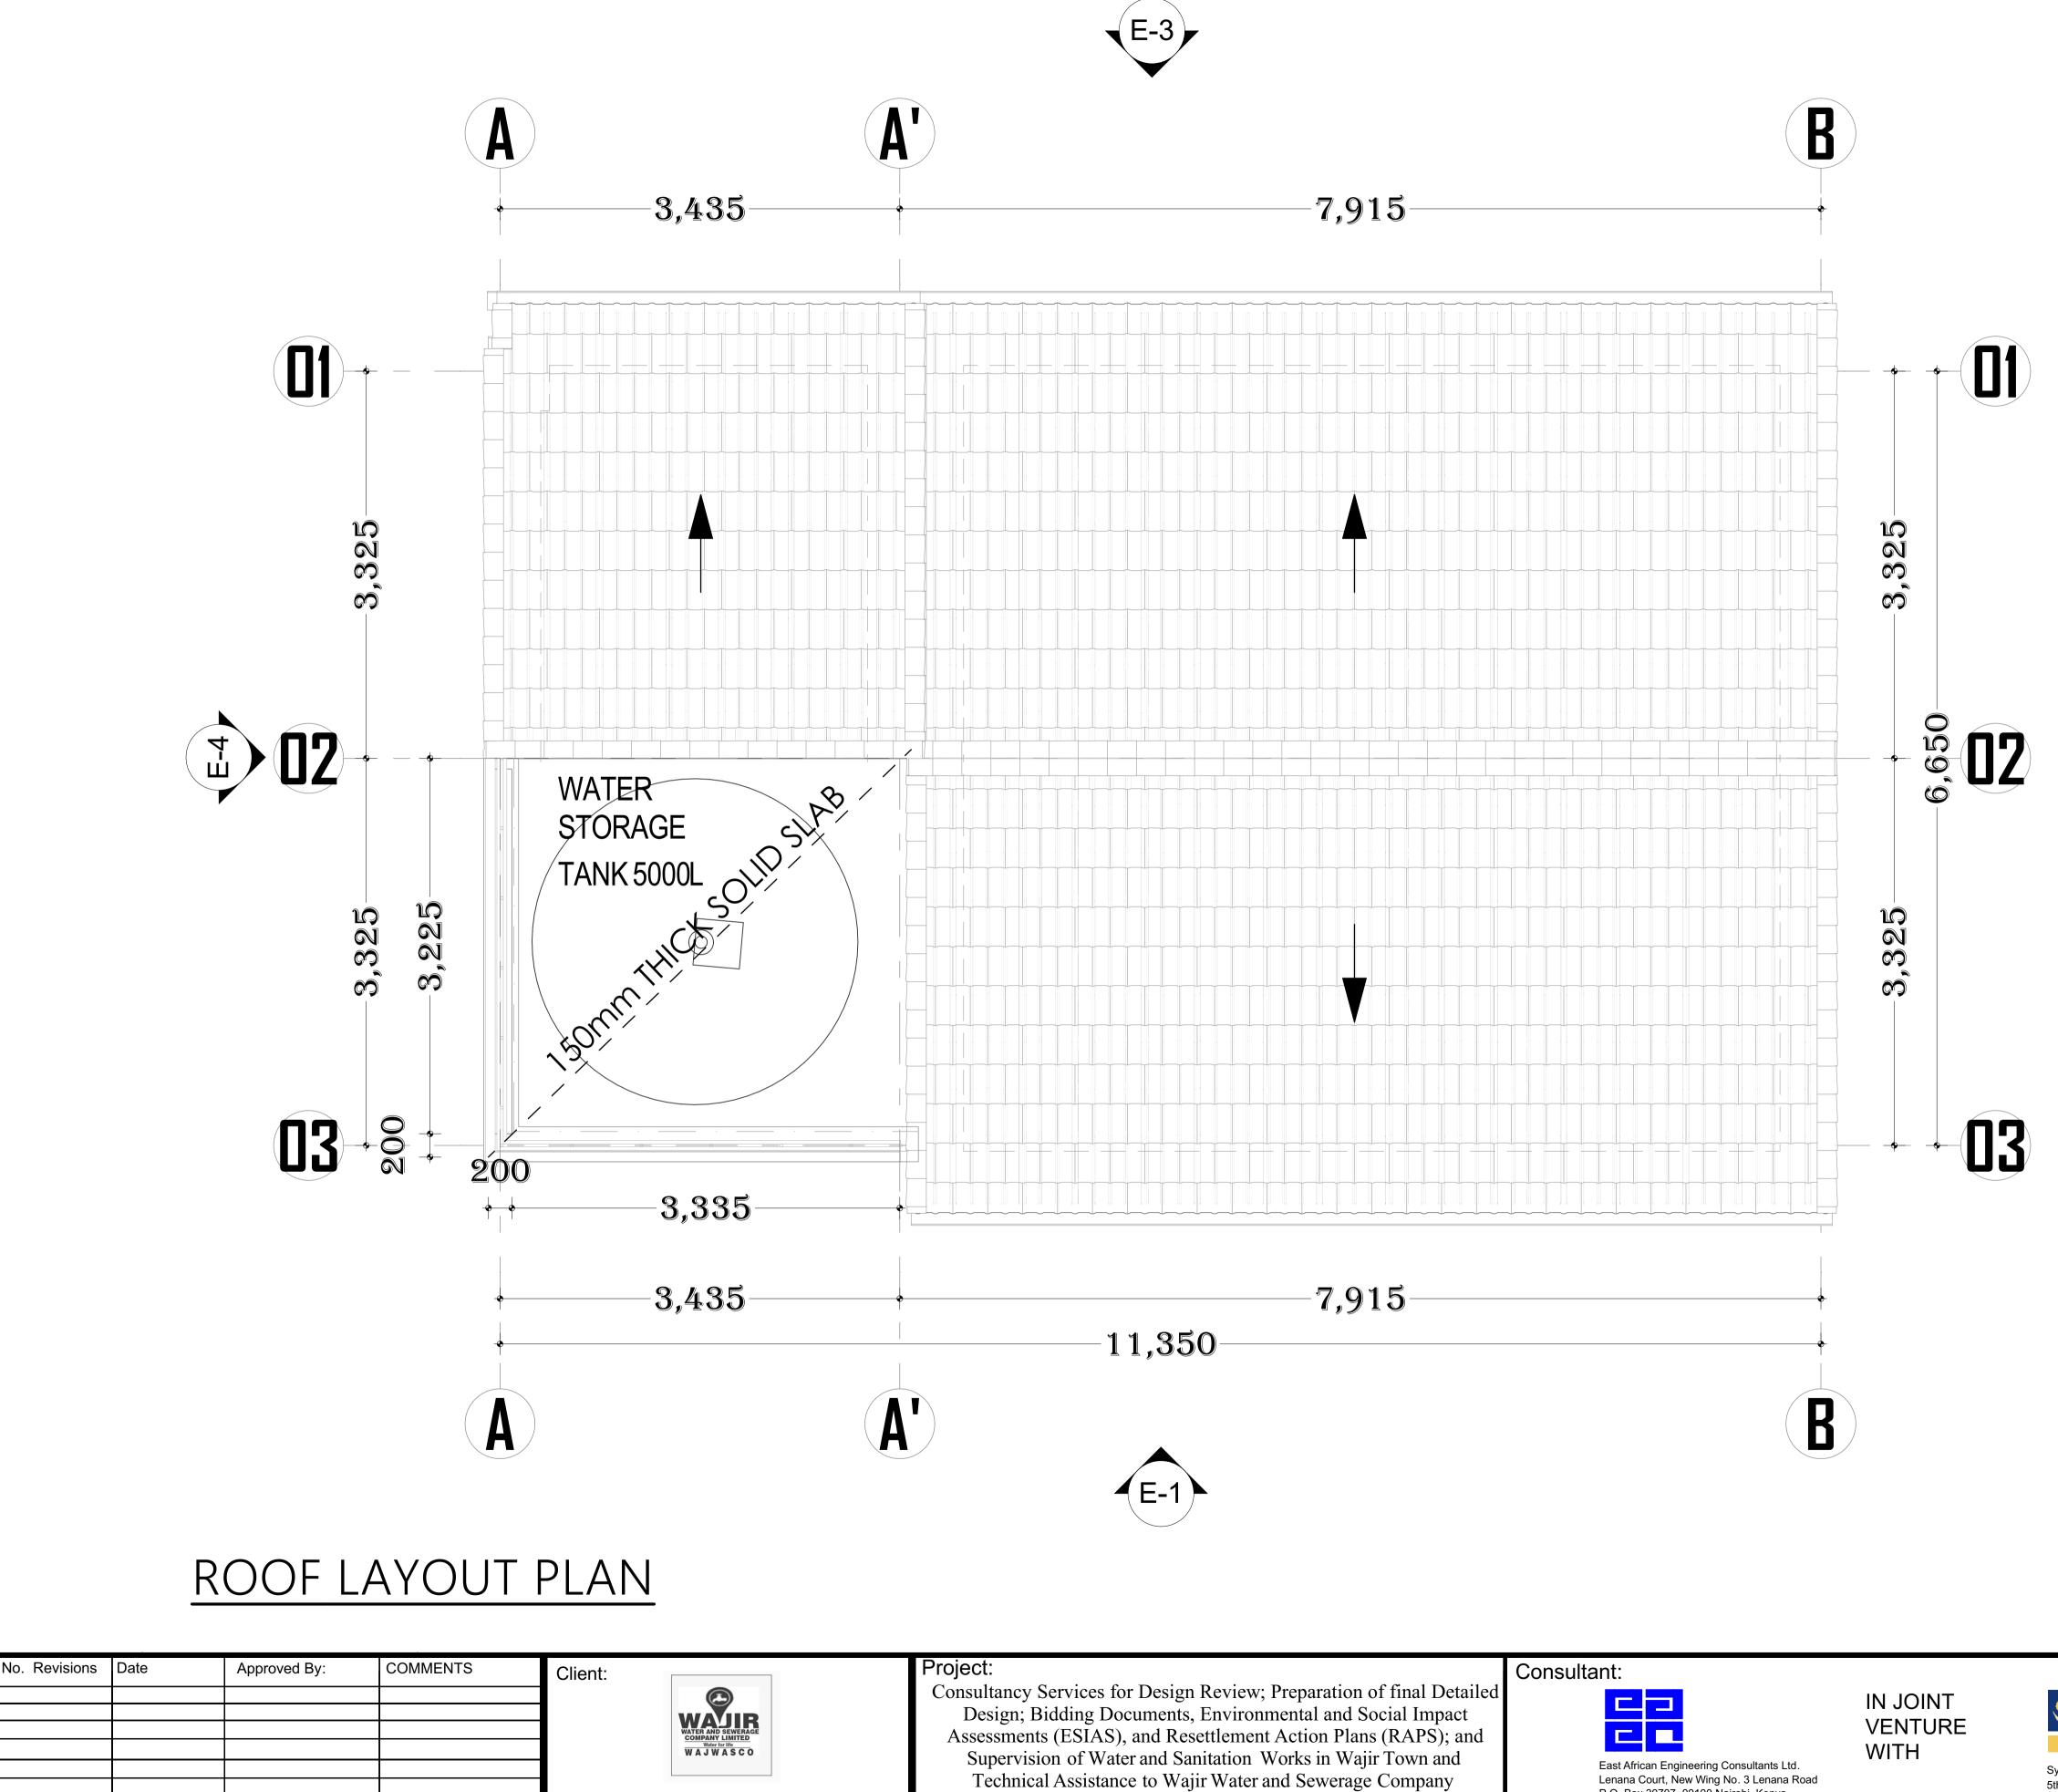

No. Revisions	Date	Approved By:	COMMENTS	Client:			Project:
							Consultancy Services for Design R
							Design; Bidding Documents, E
					WATER AND SEWERAGE COMPANY LIMITED		Assessments (ESIAS), and Reset
					Water for life WAJWASCO		Supervision of Water and Sanit
							Technical Assistance to Wajir
				MANAGING I	DIRECTOR V	VAJIR WATER	PHASE I - DE
				AND SEW	ERAGE CON	MPANY LTD	Drawing Title:ROOF LAYOUT
				P.O BO	X 708 WAJIF	R, KENYA	Draming montoor LATOOT
						•	

PHASE I - DESIGN REVIEW

Lenana Court, New Wing No. 3 Lenana Road P.O. Box 30707, 00100 Nairobi, Kenya Tel: (+254)-20-2714514/5/6 (+254) - 20 - 2527995 / 2718861 Email: <u>eaecgroup@gmail.com</u>, info@eaecgroup.com MMM ABACATOLID CC

Systel Engine 5th Floor, Win Mara Road, I P.O Box 1910 Nairobi, Keny Tel: + 254(0) Email:consul

NOTES	
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- 1. All measurements are in metres.
- 2. All heights are orthometric.
- 3. Contour interval is 0.25m

4. Total Area - 12.291ha (30.372acres) approx.

	Surv	ey Projection
Projection	UTM	
Datum	WGS 84	
Zone	37° NORTH	

### LEGEND:

- 1. Major Contour 2. Minor Contour 3. Spot Height+ Value 4. Access 5. Canal
  - E

МН

8. Fence

7. Tree

6. Building


9. Control Point

10. Wall

11. Manhole

$\mathbf{\hat{N}}$	
Ш	


	DESIGNED BY: AMM	DRAWN BY: AMM
SYSTEL.	CHECKED BY: AM	APPROVED BY: DNS
NEERING LTD	SCALE: 1:500 (A1)	DATE: December2022
ing II, CIC Plaza, Upperhill, 09-00100,	JOB No. C779	SHEET 1 OF 1
09-00100, ya 791 329 980 / 726 039 006 ting@systelengineering.com	DRAWING No. WFSTP/SW/WRS/1.0/2	Revision A B C D E F G H I J K L

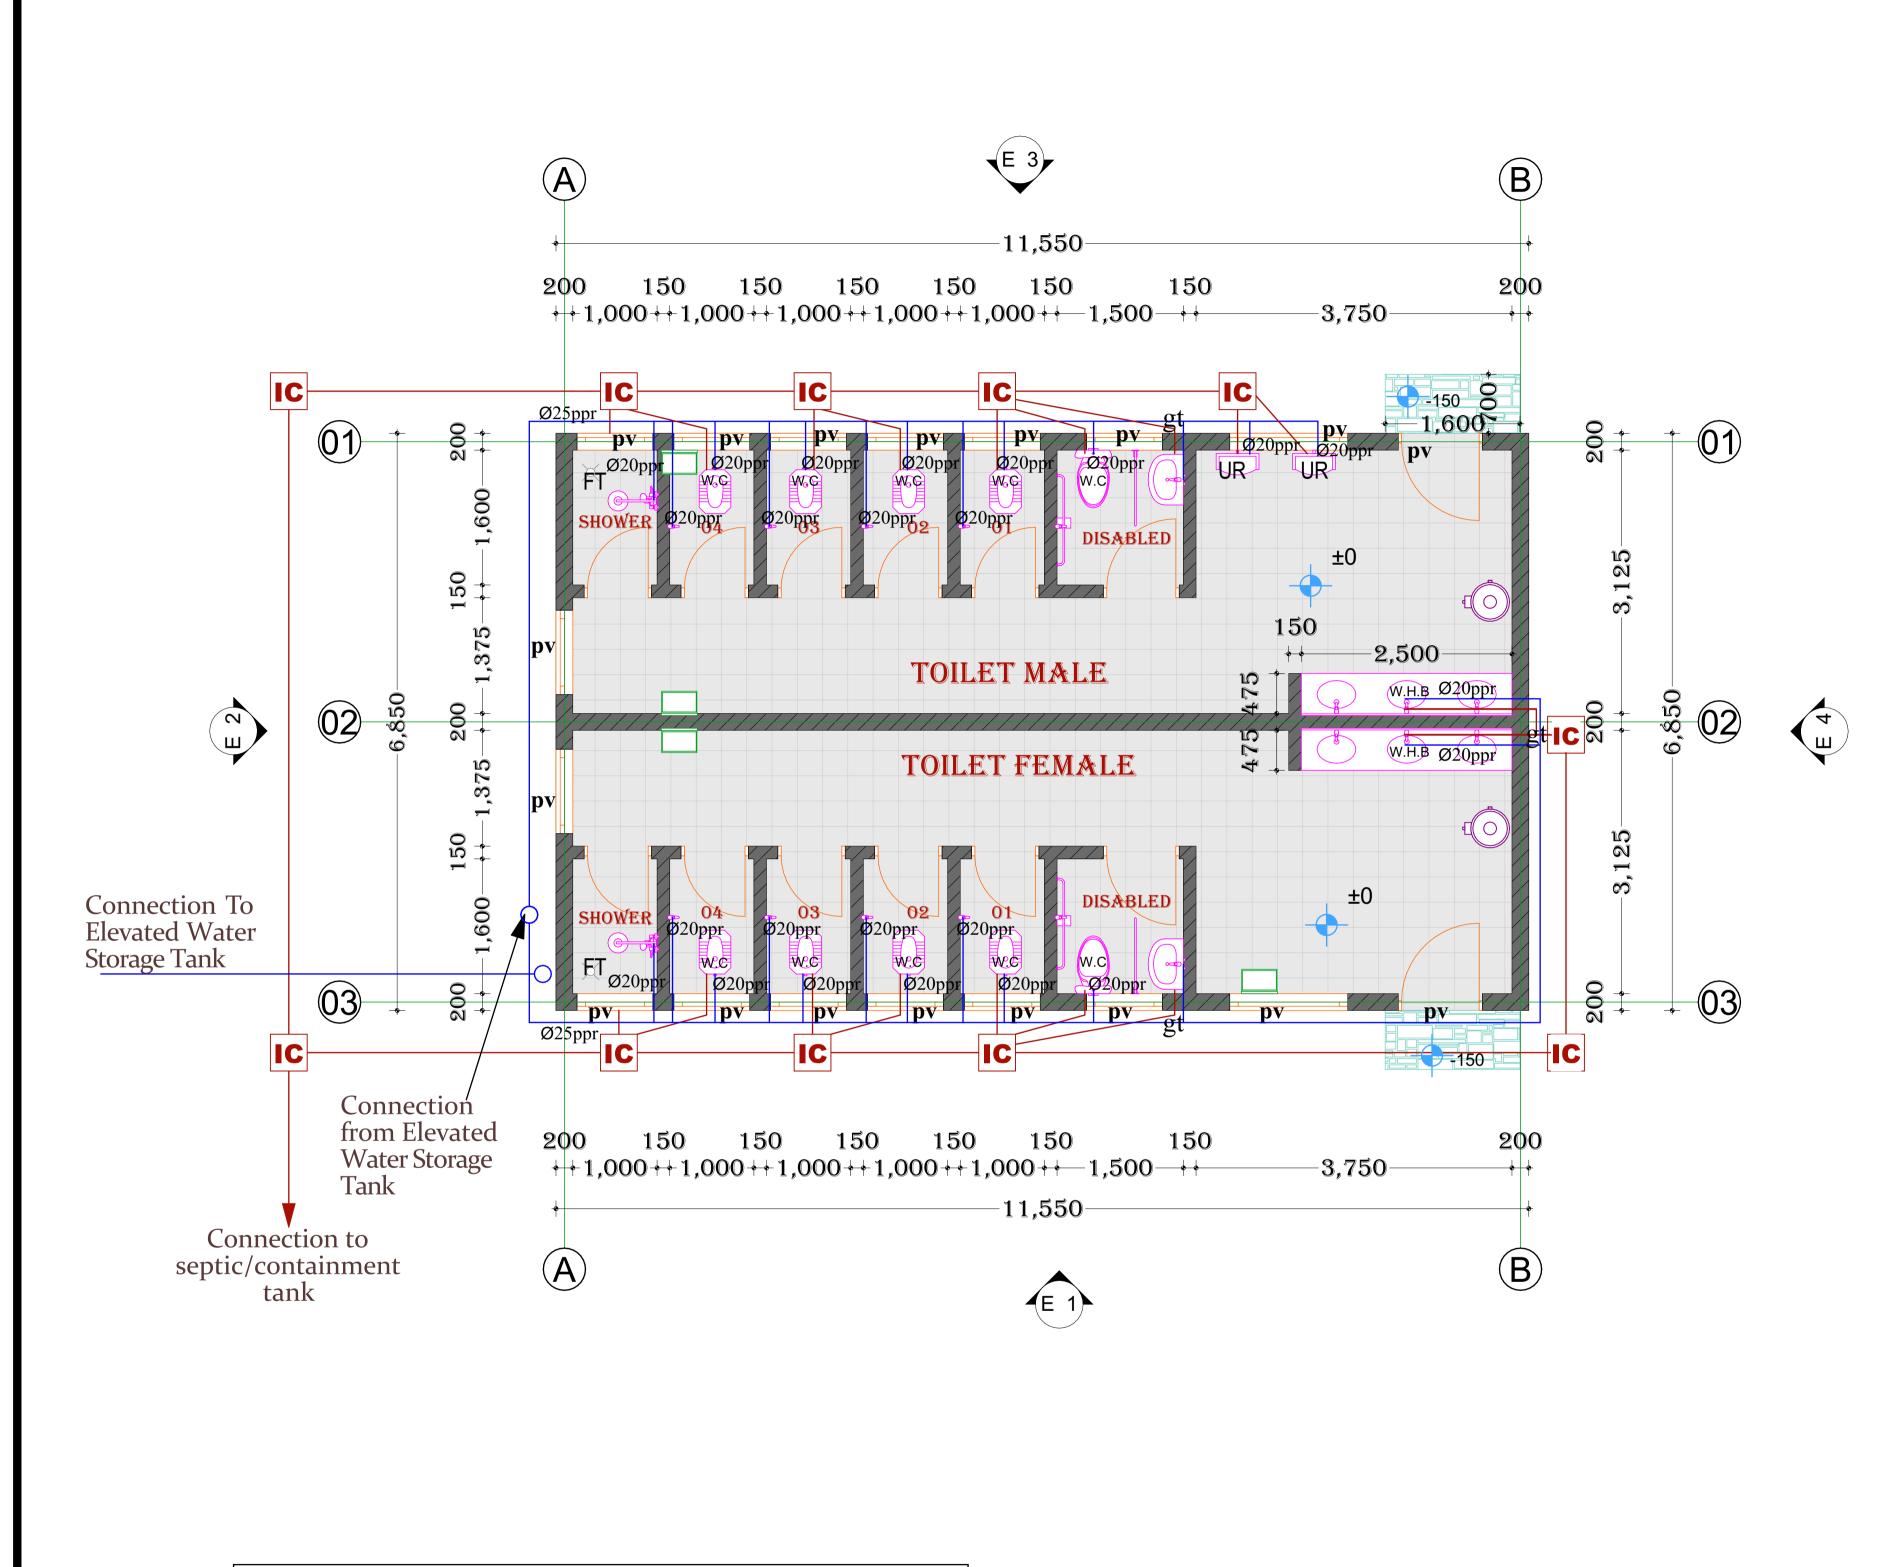

# PLUMBING LAYOUT PLAN [FOUL WATER AND CLEAN WATER FOR USE]

No. Revisions	Date	Approved By:	COMMENTS	Client:	Project:
					Consultan
				WAJIR	Design
				WATER AND SEWERAGE COMPANY LIMITED Water for life W A J W A S C O	Assessm
					Super
					Tech
				MANAGING DIRECTOR WAJIR WATER	
				AND SEWERAGE COMPANY LTD	Drawing T
	_			P.O BOX 708 WAJIR, KENYA	

А	BBREVIATIONS - PLUMBING
NO	NORMALLY OPEN
NPW	NON-POTABLE WATER
OD	OUTSIDE DIAMETER
OS&Y	OUTSIDE SCREW & YOKE GATE VALVE
OST	OVERFLOW STORM
FT	FLOOR TRAP
GT	GULLEY TRAP
PRV	PRESSURE REDUCING VALVE
PSI	POUNDS PER SQUARE INCH
PSIG	POUNDS PER SQUARE INCH (GAUGE)
RISE	RISE (WITH IN FLOOR)
SA	SHOCK ABSORBER
SAN	SANITARY
SD	SMOKE DETECTOR
SF	SQUARE FEET
SK	SINK
ST	STORM PIPING
TD	TRENCH DRAIN
TDH	TOTAL DISCHARGE HEAD
TMV	TEMPERATURE MIXING VALVE
TOP	TOP OF PIPE
TOS	TOP OF SLAB
TP	TRAP PRIMER
TPV	TRAP PRIMER VALVE
TS	TAMPER SWITCH
TYP	TYPICAL
UON	UNLESS OTHERWISE NOTED
UP	UP (PENETRATES FLOOR SLAB)
UR	URINAL
V	VENT
VB	VACUUM BREAKER
VR	VENT RISE
VTR	VENT THROUGH ROOF
WC	WATER CLOSET
WCO	WALL CLEANOUT
WHB	WALL HAND BASIN
WF	WATER FILTER
WFU	WATER FIXTURE UNIT
Z	ZONE

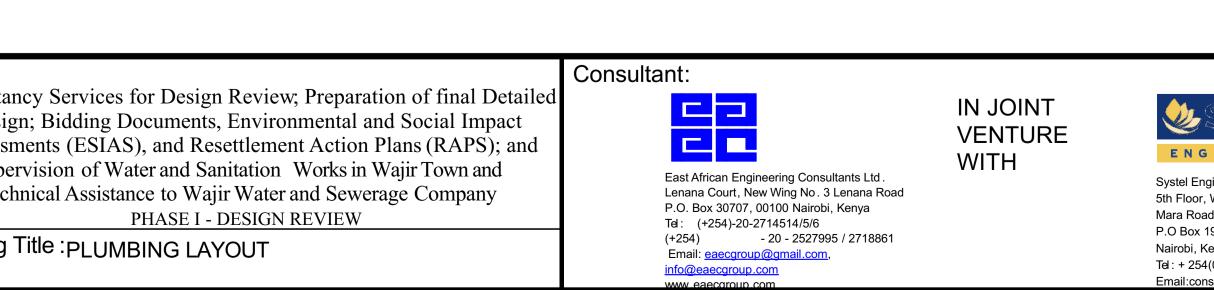

NOTES	5
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- 1. All measurements are in metres.
- 2. All heights are orthometric.
- 3. Contour interval is 0.25m

4. Total Area - 12.291ha (30.372acres) approx.

	Surv	ey Projection
Projection	UTM	
Datum	WGS 84	
Zone	37° NORTH	

### LEGEND:

1. Major Contour
2. Minor Contour
3. Spot Height+ Value →v <sup>⊗36</sup>
4. Access
5. Canal

MH

6. Building

7. Tree

8. Fence


9. Control Point

10. Wall

11. Manhole

PIPING LEGEND		
	COLD WATER PIPING	
	SOIL VENT PIPE	
IC	INSPECTION CHAMBER	
0	COLD WATER PIPING WITH CONNECTION TO ABOVE	

	DESIGNED BY: AMM	DRAWN BY: AMM	
SYSTEL.	CHECKED BY: AM	APPROVED BY: SCW	
GINEERING LTD ngineering Limited r, Wing II, CIC Plaza, ad, Upperhill, 19109-00100,	SCALE: 1:500 (A1)	DATE: June2023	
	JOB No. C779	SHEET 1 OF 1	
Kenya 4(0) 791 329 980 / 726 039 006 nsulting@systelengineering.com	DRAWING No. WFSTP/SW/WRS/1.0/3	RevisionABCDEFGHIJKL	

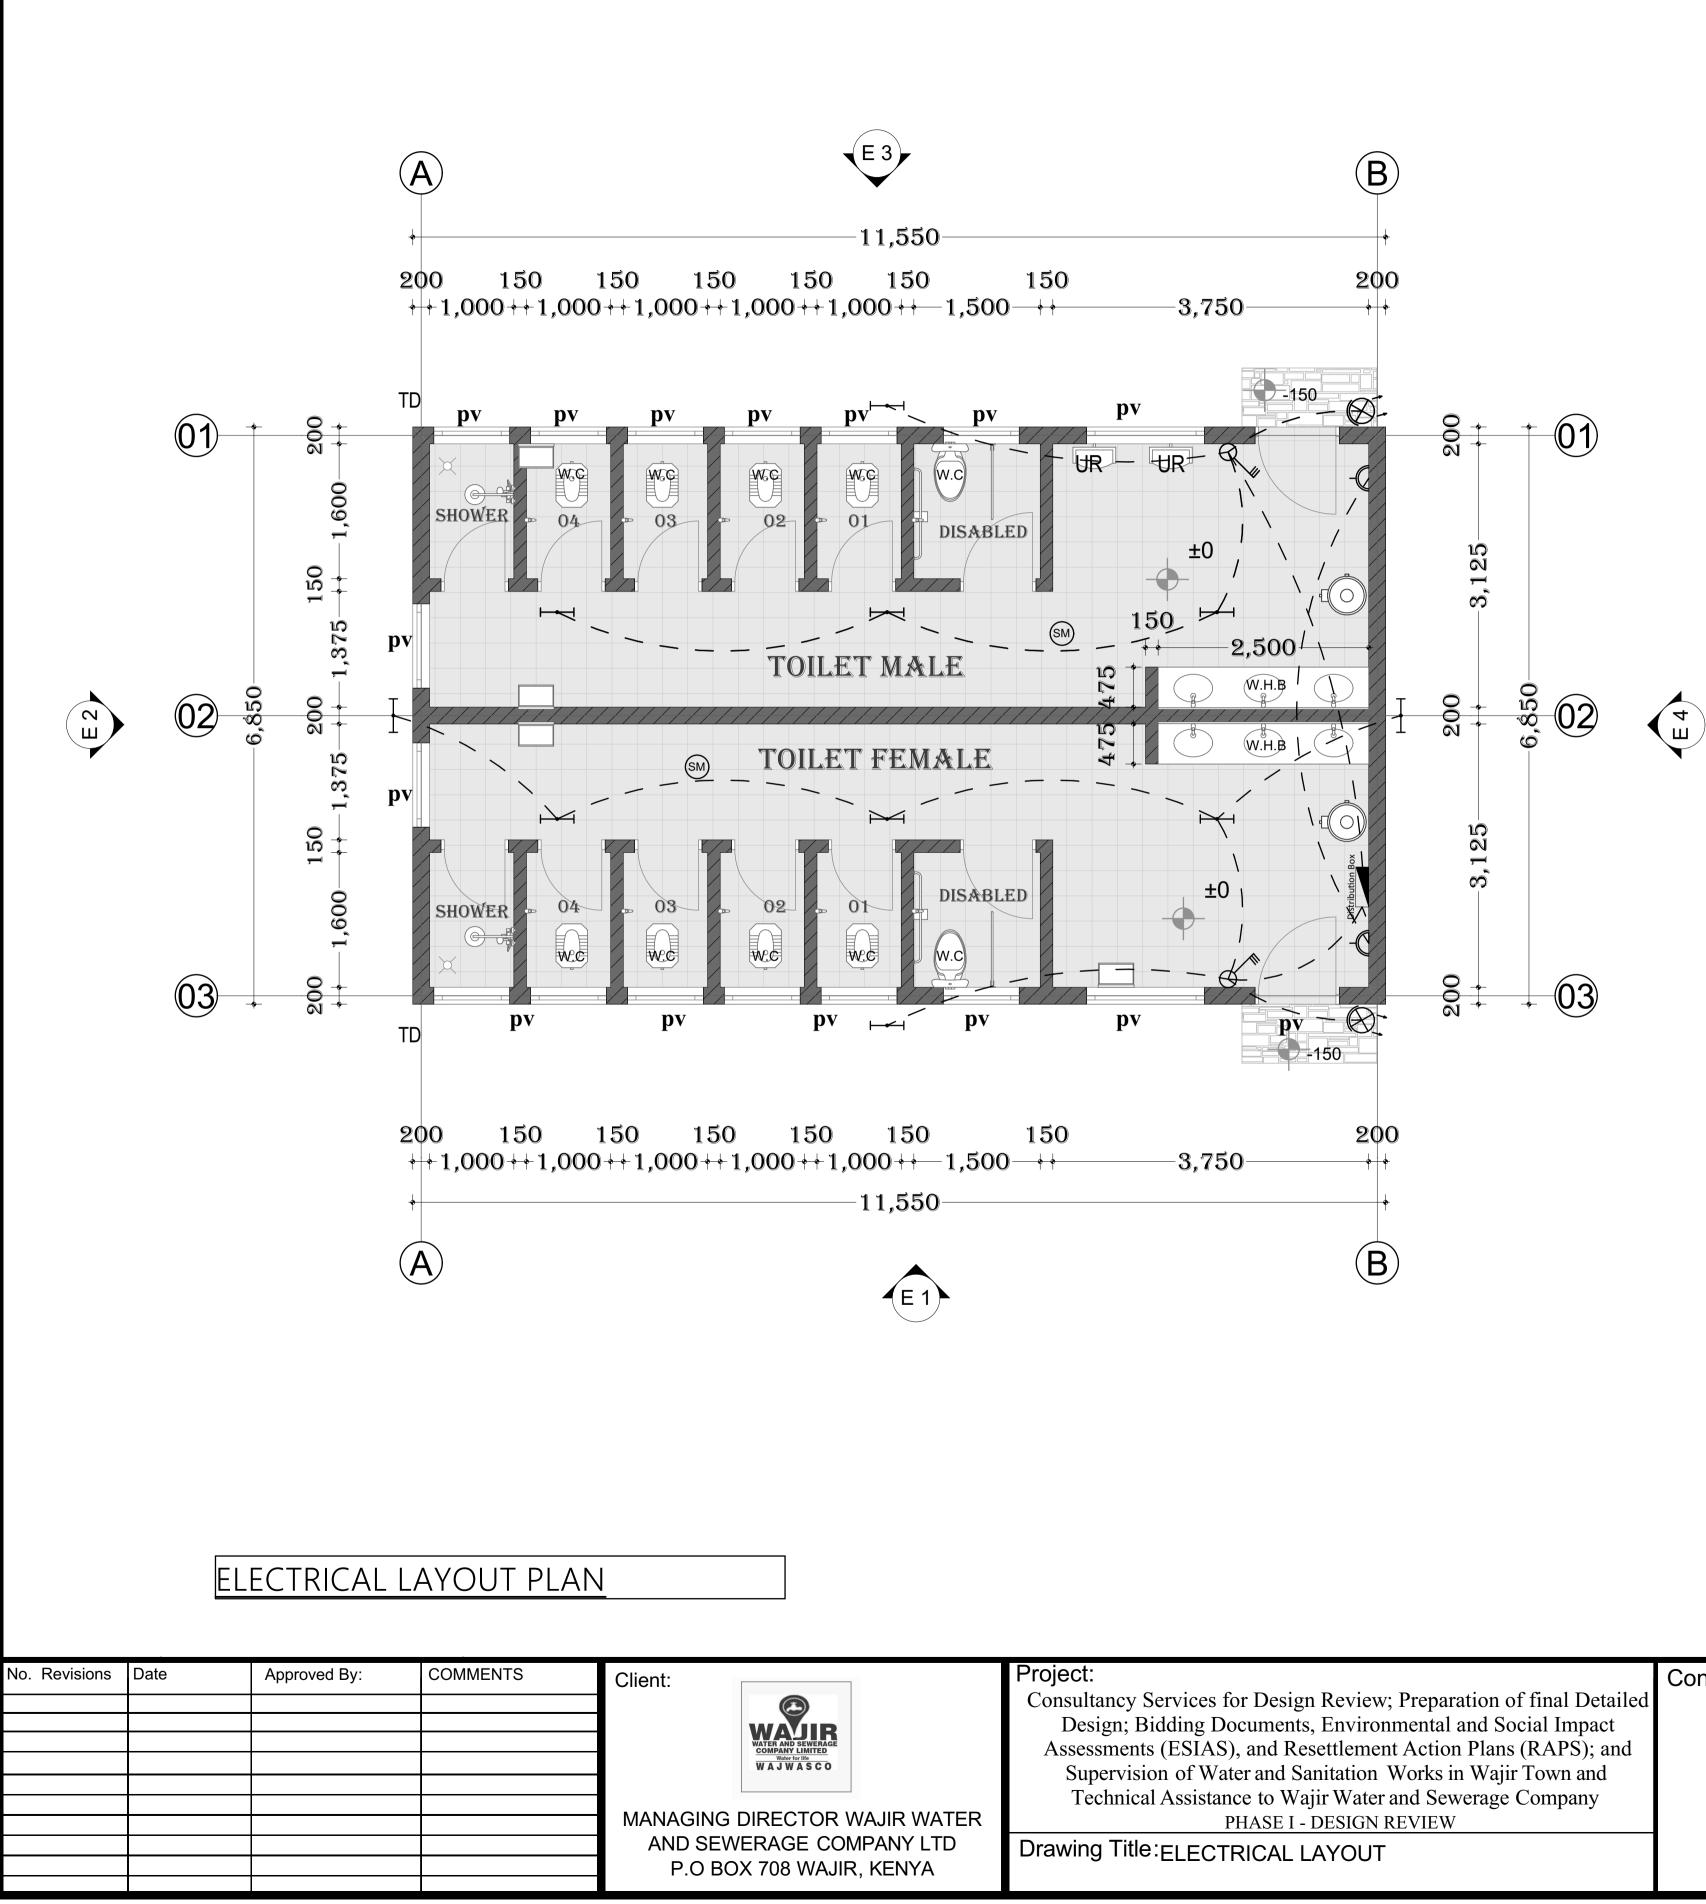

	LEGEND:
SYMBOL	INDICATES CEILING HEIGHT
<b>^</b> 0	Switch 3 Poles One Way
$\oplus$	SURFACE MOUNTED OR PENDANT LIGHT FIXTURE ("EX" INDICATES EXTERIOR FIXTURE & "P" INDICATES POST FIXTURE)
$\overline{\oplus}$	SURFACE MOUNTED FAN W/ LIGHT FIXTURE
F Ø	RECESSED POT LIGHT ("WP" INDICATES WATERPROOF)
	RECESSED OR SURFACE MOUNTED STRIP LIGHT
•	Socket Outlet Multiple 2 Gangs
$\Phi$	SURFACE MOUNTED DECORATIVE WALL SCONCE ("EX" INDICATES EXTERIOR FIXTURE)
₽	SURFACE MOUNTED LED WALL LIGHT FIXTURE (TO BE LOCATED ABOVE DOOR OPENING ON CENTER OF OPENING)
FAN	EXHAUST FAN
SM	SMOKE ALARM
нч	· Fluorescent Lighting
Φ	WALL MOUNTED DUPLEX OUTLET TO BE LOCATED AS PER O.B.C. UNLESS OTHERWISE NOTED. "AC" REPRESENTS "ABOVE COUNTER", "EX" - EXTERIOR
$\bigcirc$	OUTLET LOCATED IN MILLWORK. REFER TO MILLWORK DETAILS FOR CLARIFICATION (ID-500'S)
ф <sub>GFI</sub>	WALL MOUNTED DUPLEX OUTLET WITH GROUND FAULT TO BE LOCATED AS PER O.B.C. UNLESS OTHERWISE NOTED. "AC" REPRESENTS "ABOVE COUNTER".
Ø:	Spot Light Symbol
$\rightarrow$	WALL MOUNTED CABLE OUTLET AND RECESSED BOX FOR OUTLET & CABLE CONNECTION TO BE LOCATED AS SPECIFIED
	Distribution Box
	ECTED CEILING & ELECTRICAL
	NOTES: 0 INTERIOR DESIGN LIGHTING SCHEDULE FOR ALL LIGHTING 7
DISCREPAN ATTENTION 3. ALL ELEC OTHERWIS INTERIOR D	L CONTRACTOR & ELECTRICIAN TO REVIEW DRAWINGS FOR ANY NCIES. ANY DRAWING DISCREPANCIES SHALL BE BROUGHT TO THE OF THE INTERIOR DESIGN CONSULTANT PRIOR TO CONSTRUCTION CTRICAL SWITCHES TO BE LOCATED 42" OC. AFF. UNLESS E NOTED. SWITCH LOCATIONS TO BE CONFIRMED WITH CLIENT & DESIGN CONSULTANT PRIOR TO INSTALLATION.
CONSULTA TAKEN FRO	GHT FIXTURES TO HAVE DIMMER, CONFIRM WITH INTERIOR DESIGN NT & CLIENT PRIOR TO SWITCH INSTALLATION. 6. DIMENSIONS ARE
LOCATED C 6. FIXTURE	DM CENTER OF LIGHT FIXTURES, UNLESS OTHERWISE NOTED. IT FIXTURES SHOWN CENTERED ON REFLECTED CEILING PLAN TO BI ENTERED ON SITE, UNLESS OTHERWISE NOTED QUANTITIES TO BE VERIFIED BY INSTALLER PRIOR TO ORDERING ORATIVE SURFACE MOUNTED FIXTURES TO BE SPECIFIED OR
LOCATED C 6. FIXTURE 7. ALL DEC SUPPLIED E 8. ALL WAL 9. DIMENSI OTHERWISI	IT FIXTURES SHOWN CENTERED ON REFLECTED CEILING PLAN TO BU CENTERED ON SITE, UNLESS OTHERWISE NOTED QUANTITIES TO BE VERIFIED BY INSTALLER PRIOR TO ORDERING ORATIVE SURFACE MOUNTED FIXTURES TO BE SPECIFIED OR BY CLIENT TO BE INSTALLED BY ELECTRICIAN L SCONCES TO BE LOCATED AS PER INTERIOR DESIGN DRAWINGS, ONS ARE TAKEN FROM THE CENTER OF OUTLETS, UNLESS E NOTED.
LOCATED C 6. FIXTURE 7. ALL DEC SUPPLIED E 8. ALL WAL 9. DIMENSI OTHERWISE 10.ALL OUT OTHERWISE	IT FIXTURES SHOWN CENTERED ON REFLECTED CEILING PLAN TO B CENTERED ON SITE, UNLESS OTHERWISE NOTED QUANTITIES TO BE VERIFIED BY INSTALLER PRIOR TO ORDERING ORATIVE SURFACE MOUNTED FIXTURES TO BE SPECIFIED OR BY CLIENT TO BE INSTALLED BY ELECTRICIAN L SCONCES TO BE LOCATED AS PER INTERIOR DESIGN DRAWINGS, ONS ARE TAKEN FROM THE CENTER OF OUTLETS, UNLESS E NOTED. LETS TO BE LOCATED ON CENTER (O.C.), OF WALL UNLESS E NOTED.
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LOCATED C 6. FIXTURE 7. ALL DEC SUPPLIED B 8. ALL WAL 9. DIMENSI 0THERWISI 10.ALL OUT 0THERWISI 11.ALL WAL 0DECORA" U 12.ALL ABC 0THERWISI 13.SECURIT LOCATIONS	IT FIXTURES SHOWN CENTERED ON REFLECTED CEILING PLAN TO BI CENTERED ON SITE, UNLESS OTHERWISE NOTED QUANTITIES TO BE VERIFIED BY INSTALLER PRIOR TO ORDERING ORATIVE SURFACE MOUNTED FIXTURES TO BE SPECIFIED OR BY CLIENT TO BE INSTALLED BY ELECTRICIAN L SCONCES TO BE LOCATED AS PER INTERIOR DESIGN DRAWINGS, ONS ARE TAKEN FROM THE CENTER OF OUTLETS, UNLESS E NOTED. LETS TO BE LOCATED ON CENTER (O.C.), OF WALL UNLESS E NOTED. L MOUNTED ELECTRICAL OUTLETS & SWITCHES ARE TO BE JNLESS OTHERWISE NOTED. FINISH AS SPECIFIED.
LOCATED C 6. FIXTURE 7. ALL DEC SUPPLIED B 8. ALL WAL 9. DIMENSI 0THERWISI 10.ALL OUT 0THERWISI 11.ALL WAL 12.ALL ABC 0THERWISI 13.SECURI 14.ALL OUT BOX WITH C BE INDICAT	IT FIXTURES SHOWN CENTERED ON REFLECTED CEILING PLAN TO BI CENTERED ON SITE, UNLESS OTHERWISE NOTED QUANTITIES TO BE VERIFIED BY INSTALLER PRIOR TO ORDERING ORATIVE SURFACE MOUNTED FIXTURES TO BE SPECIFIED OR BY CLIENT TO BE INSTALLED BY ELECTRICIAN L SCONCES TO BE LOCATED AS PER INTERIOR DESIGN DRAWINGS, ONS ARE TAKEN FROM THE CENTER OF OUTLETS, UNLESS E NOTED. LETS TO BE LOCATED ON CENTER (O.C.), OF WALL UNLESS E NOTED. L MOUNTED ELECTRICAL OUTLETS & SWITCHES ARE TO BE JNLESS OTHERWISE NOTED. FINISH AS SPECIFIED. VE COUNTER OUTLETS TO BE LOCATED 42" OC. AFF. UNLESS E NOTED. Y ALARM, AUDIO/VISUAL & HOME AUTOMATION COMPONENT S TO BE CONFIRMED WITH CLIENT & ALL OTHER CONSULTANTS INSTALLATION. LETS PLACED TOGETHER TO BE GANGED INTO SINGLE ROUGH IN DNE COVER PLATE AS REQUIRED. SPECIFIC MOUNTING HEIGHTS TO ED ON INTERIOR DESIGN ELECTRICAL PLANS.
LOCATED C 6. FIXTURE 7. ALL DEC SUPPLIED E 8. ALL WAL 9. DIMENSI 0THERWISI 10.ALL OUT 10.ALL OUT 11.ALL WAL "DECORA" ( 11.ALL WAL "DECORA" ( 12.ALL ABC 0THERWISI 13.SECURIT LOCATIONS PRIOR TO II 14.ALL OUT BOX WITH ( BE INDICAT 15. ELECTR PER TRADE TO BE PRO	IT FIXTURES SHOWN CENTERED ON REFLECTED CEILING PLAN TO BI CENTERED ON SITE, UNLESS OTHERWISE NOTED QUANTITIES TO BE VERIFIED BY INSTALLER PRIOR TO ORDERING ORATIVE SURFACE MOUNTED FIXTURES TO BE SPECIFIED OR BY CLIENT TO BE INSTALLED BY ELECTRICIAN L SCONCES TO BE LOCATED AS PER INTERIOR DESIGN DRAWINGS, ONS ARE TAKEN FROM THE CENTER OF OUTLETS, UNLESS E NOTED. LETS TO BE LOCATED ON CENTER (O.C.), OF WALL UNLESS E NOTED. L MOUNTED ELECTRICAL OUTLETS & SWITCHES ARE TO BE JNLESS OTHERWISE NOTED. FINISH AS SPECIFIED. VE COUNTER OUTLETS TO BE LOCATED 42" OC. AFF. UNLESS E NOTED. Y ALARM, AUDIO/VISUAL & HOME AUTOMATION COMPONENT S TO BE CONFIRMED WITH CLIENT & ALL OTHER CONSULTANTS INSTALLATION.

:: Itancy Services for Design Review; Preparation of final Detailed sign; Bidding Documents, Environmental and Social Impact ssments (ESIAS), and Resettlement Action Plans (RAPS); and pervision of Water and Sanitation Works in Wajir Town and echnical Assistance to Wajir Water and Sewerage Company <u>PHASE I - DESIGN REVIEW</u> og Title:ELECTRICAL LAYOUT	Consultant: East African Engineering Consultants Ltd. Lenana Court, New Wing No. 3 Lenana Road P.O. Box 30707, 00100 Nairobi, Kenya Tel: (+254)-20-2714514/5/6 (+254) - 20 - 2527995 / 2718861 Email: eaecgroup@gmail.com, info@eaecgroup.com	IN JOINT VENTURE WITH	E N G Systel Eng 5th Floor, M Mara Road P.O Box 19 Nairobi, Ke Tel: + 254( Email:cons

NOTES	•
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- 1. All measurements are in metres.
- 2. All heights are orthometric.
- 3. Contour interval is 0.25m

4. Total Area - 12.291ha (30.372acres) approx.

	Surv	ey Projection
Projection	UTM	
Datum	WGS 84	
Zone	37° NORTH	

L	EG	ΕN	D	

1. Major Contour	
2. Minor Contour	
3. Spot Height+ Value	• 11 <sup>9,315</sup>
4. Access	
5. Canal	

E

МН

Building
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7. Tree

6.

8. Fence

9. Control Point

10. Wall

11. Manhole

	DESIGNED BY: AMM	DRAWN BY: AMM
NEERING LTD	CHECKED BY: AM	APPROVED BY: DNS
	SCALE: 1:500 (A1)	DATE: December2022
ing II, CIC Plaza, Upperhill, I09-00100,	JOB No. C779	SHEET 1 OF 1
ya ) 791 329 980 / 726 039 006 Iting@systelengineering.com	DRAWING No. WFSTP/SW/WRS/1.0/4	RevisionABCDEFGHIJKL




			Consultar Desig
		WATER AND SEWERAGE COMPANY LIMITED Water for life W A J W A S C O	Assessm
		WAJWASCO	Super Tech
		MANAGING DIRECTOR WAJIR WATER	
		AND SEWERAGE COMPANY LTD P.O BOX 708 WAJIR, KENYA	Drawing

sments (ESIAS), and Resettlement Action Plans (RAPS); and pervision of Water and Sanitation Works in Wajir Town and chnical Assistance to Wajir Water and Sewerage Company PHASE I - DESIGN REVIEW

Title:VIEWS

East African Engineering Consultants Ltd. Lenana Court, New Wing No. 3 Lenana Road P.O. Box 30707, 00100 Nairobi, Kenya Tel: (+254)-20-2714514/5/6 (+254) - 20 - 2527995 / 2718861 Email: <u>eaecgroup@gmail.com</u>, <u>info@eaecgroup.com</u>

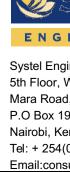

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	Surv	ey Projection
Projection	UTM	
Datum	WGS 84	
Zone	37° NORTH	

### LEGEND:

1. Major Contour 2. Minor Contour 3. Spot Height+ Value 4. Access 5. Canal 6. Building

MH

- 7. Tree
- 8. Fence
- 9. Control Point
- 10. Wall
- 11. Manhole

	DESIGNED BY: AMM	DRAWN BY: AMM
SYSTEL.	CHECKED BY: AM	APPROVED BY: DNS
GINEERING LTD	SCALE: 1:500 (A1)	DATE: December2022
Wing II, CIC Plaza, ad, Upperhill, 19109 00100	JOB No. C779	SHEET 1 OF 1
19109-00100, Kenya I(0) 791 329 980 / 726 039 006 Isulting@systelengineering.com	DRAWING No. WFSTP/SW/WRS/1.0/v	RevisionABCDEFGHIJKL

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VIEW 02

No. Revisions	Date	Approved By:	COMMENTS	Client:	Project:
					Consulta
					Desig
				WATER AND SEWERAGE COMPANY LIMITED Water for life W A J W A S C O	Assess
				W A J W A S C O	Supe
					Tec
				MANAGING DIRECTOR WAJIR WATE	ĒR
				AND SEWERAGE COMPANY LTD	Drawing
				P.O BOX 708 WAJIR, KENYA	Dramig
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Itancy Services for Design Review; Preparation of final Detailed sign; Bidding Documents, Environmental and Social Impact ssments (ESIAS), and Resettlement Action Plans (RAPS); and pervision of Water and Sanitation Works in Wajir Town and echnical Assistance to Wajir Water and Sewerage Company PHASE I - DESIGN REVIEW

Title:VIEWS

Consultant:



East African Engineering Consultants Ltd. Lenana Court, New Wing No. 3 Lenana Road P.O. Box 30707, 00100 Nairobi, Kenya Tel: (+254)-20-2714514/5/6 (+254) - 20 - 2527995 / 2718861 Email: <u>eaecgroup@gmail.com</u>, <u>info@eaecgroup.com</u> IN JOINT VENTURE WITH



Mara Road, U P.O Box 191 Nairobi, Keny Tel: + 254(0) Email:consul NOTES:

- 1. All measurements are in metres.
- 2. All heights are orthometric.
- 3. Contour interval is 0.25m

4. Total Area - 12.291ha (30.372acres) approx.

	Surv	ey Projection
Projection	UTM	
Datum	WGS 84	
Zone	37° NORTH	

	Datum	WGS 8	34	
	Zone	37° N0	ORTH	
AN	LEGEN			
	1. Major	Contour		
NA A	2. Minor	<sup>-</sup> Contour		
	3. Spot	Height+ Value	• •1 <sup>9,31</sup>	
No Al	4. Acces	55		
	5. Cana	I		_
	6. Buildi	ng		
	7. Tree		E	
	8. Fence	e 🦯	6	
	9. Contr	ol Point	#1 <sup>26),951</sup> W1	
	10. Wall	•	$\checkmark$	
	11. Man	hole	МН	7
C APARA III				
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AN ALL AND				
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Fin the second second	DESIGNED E	BY: AMM	DRAWN	BY: AMM
INEERING LTD	CHECKED B			ED BY: DNS
gineering Limited Wing II, CIC Plaza,	SCALE: 1:50			ecember2022
d, Upperhill, 9109-00100, enya	JOB No. C77 DRAWING N			T 1 OF 1 evision
(0) 791 329 980 / 726 039 006 sulting@systelengineering.com	WFSTP/SW/	WRS/1.0/v	A G	B C D E F H I J K L
				<b>≥</b>



No. Revisions	Date	Approved By:	COMMENTS	Client:	Project:
					Consulta
				WAJIB	Desi
				WATER AND SEWERAGE COMPANY LIMITED	Assess
				W A J W A S C O	Supe
					Tec
				MANAGING DIRECTOR WAJIR WATER	
				AND SEWERAGE COMPANY LTD	Drawing
				P.O BOX 708 WAJIR, KENYA	Brawing

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Consultant:



East African Engineering Consultants Ltd. Lenana Court, New Wing No. 3 Lenana Road P.O. Box 30707, 00100 Nairobi, Kenya Tel: (+254)-20-2714514/5/6 (+254) - 20 - 2527995 / 2718861 Email: <u>eaecgroup@gmail.com</u>, <u>info@eaecgroup.com</u> www.eaecgroup.com

IN JOINT VENTURE WITH



NOTES:

- 1. All measurements are in metres.
- 2. All heights are orthometric.
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4. Total Area - 12.291ha (30.372acres) approx.

	Surv	ey Projection
Projection	UTM	
Datum	WGS 84	
Zone	37° NORTH	

### LEGEND:

- 1. Major Contour 2. Minor Contour 3. Spot Height+ Value 4. Access 5. Canal 6. Building 7. Tree 8. Fence
- 9. Control Point
- 10. Wall
- 11. Manhole

MH

	DESIGNED BY: AMM	DRAWN BY: AMM
WSYSTEL.	CHECKED BY: AM	APPROVED BY: DNS
ENGINEERING LTD Systel Engineering Limited	SCALE: 1:500 (A1)	DATE: December2022
5th Floor, Wing II, CIC Plaza, Mara Road, Upperhill, P.O Box 19109-00100,	JOB No. C779	SHEET 1 OF 1
Nairobi, Kenya Tel: + 254(0) 791 329 980 / 726 039 006 Email:consulting@systelengineering.com	DRAWING No. WFSTP/SW/WRS/1.0/v	A B C D E F G H I J K L





No. Revisions	Date	Approved By:	COMMENTS	Client:	Project:
					Consulta
				WAUB	Desig
				WATER AND SEWERAGE COMPANY LIMITED	Assess
				Water for life W A J W A S C O	Supe
					Tecl
				MANAGING DIRECTOR WAJIR WATER	
				AND SEWERAGE COMPANY LTD	Drawing
				P.O BOX 708 WAJIR, KENYA	Drawing

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Title:VIEWS

Consultant:



East African Engineering Consultants Ltd. Lenana Court, New Wing No. 3 Lenana Road P.O. Box 30707, 00100 Nairobi, Kenya Tel: (+254)-20-2714514/5/6 (+254) - 20 - 2527995 / 2718861 Email: <u>eaecgroup@gmail.com</u>, <u>info@eaecgroup.com</u>



### NOTES:

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4. Total Area - 12.291ha (30.372acres) approx.

		,	,
		Surv	ey Projectio
	Projection	UTM	
	Datum	WGS 84	
	Zone	37° NORTH	
	LEGEN	D:	
	1. Major	Contour	
-	2. Minor	Contour	
4	3. Spot	Height+ Value 🎝 🔊	
12 1	4. Acces	SS	

ATA

E.J.

MH

- 5. Canal
- 6. Building
- 7. Tree
- 8. Fence
- 9. Control Point
- 10. Wall
- 11. Manhole

	DESIGNED BY: AMM	DRAWN BY: AMM
WSYSTEL.	CHECKED BY: AM	APPROVED BY: DNS
ENGINEERING LTD Systel Engineering Limited	SCALE: 1:500 (A1)	DATE: December2022
5th Floor, Wing II, CIC Plaza, Mara Road, Upperhill, P.O Box 19109-00100,	JOB No. C779	SHEET 1 OF 1
Nairobi, Kenya Tel: + 254(0) 791 329 980 / 726 039 006 Email:consulting@systelengineering.com	DRAWING No. WFSTP/SW/WRS/1.0/v	RevisionABCDEFGHIJKL
		S ⊂ Æ

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No. Revisions	Date	Approved By:	COMMENTS	Client:	Project:
					Consulta
				WAIIB	Desig
				WATER AND SEWERAGE COMPANY LIMITED	Assess
				Water for life W A J W A S C O	Supe
					Tec
				MANAGING DIRECTOR WAJIR WATER	
				AND SEWERAGE COMPANY LTD	Drawing
				P.O BOX 708 WAJIR, KENYA	Drawing

ancy Services for Design Review; Preparation of final Detailed ign; Bidding Documents, Environmental and Social Impact sments (ESIAS), and Resettlement Action Plans (RAPS); and pervision of Water and Sanitation Works in Wajir Town and chnical Assistance to Wajir Water and Sewerage Company PHASE I - DESIGN REVIEW

Title:VIEWS

Consultant:



East African Engineering Consultants Ltd. Lenana Court, New Wing No. 3 Lenana Road P.O. Box 30707, 00100 Nairobi, Kenya Tel: (+254)-20-2714514/5/6 (+254) - 20 - 2527995 / 2718861 Email: <u>eaecgroup@gmail.com</u>, info@eaecgroup.com





NOTES:

- 1. All measurements are in metres.
- 2. All heights are orthometric.
- 3. Contour interval is 0.25m

4. Total Area - 12.291ha (30.372acres) approx.


	Surv	ey Projection
Draiaatian		
Projection	UTM	
Datum	WGS 84	
Zone	37° NORTH	
		•

### LEGEND:

- 1. Major Contour 2. Minor Contour 3. Spot Height+ Value 4. Access 5. Canal 6. Building 7. Tree
- 8. Fence
- 9. Control Point
- 10. Wall
- 11. Manhole

MH

	DESIGNED BY: AMM	DRAWN BY: AMM
WSYSTEL,	CHECKED BY: AM	APPROVED BY: DNS
ENGINEERING LTD Systel Engineering Limited	SCALE: 1:500 (A1)	DATE: December2022
5th Floor, Wing II, CIC Plaza, Mara Road, Upperhill, P.O Box 19109-00100,	JOB No. C779	SHEET 1 OF 1
Nairobi, Kenya Tel: + 254(0) 791 329 980 / 726 039 006 Email:consulting@systelengineering.com	DRAWING No. WFSTP/SW/WRS/1.0/v	RevisionABCDEFGHIJKL
		\$∕_∕≾

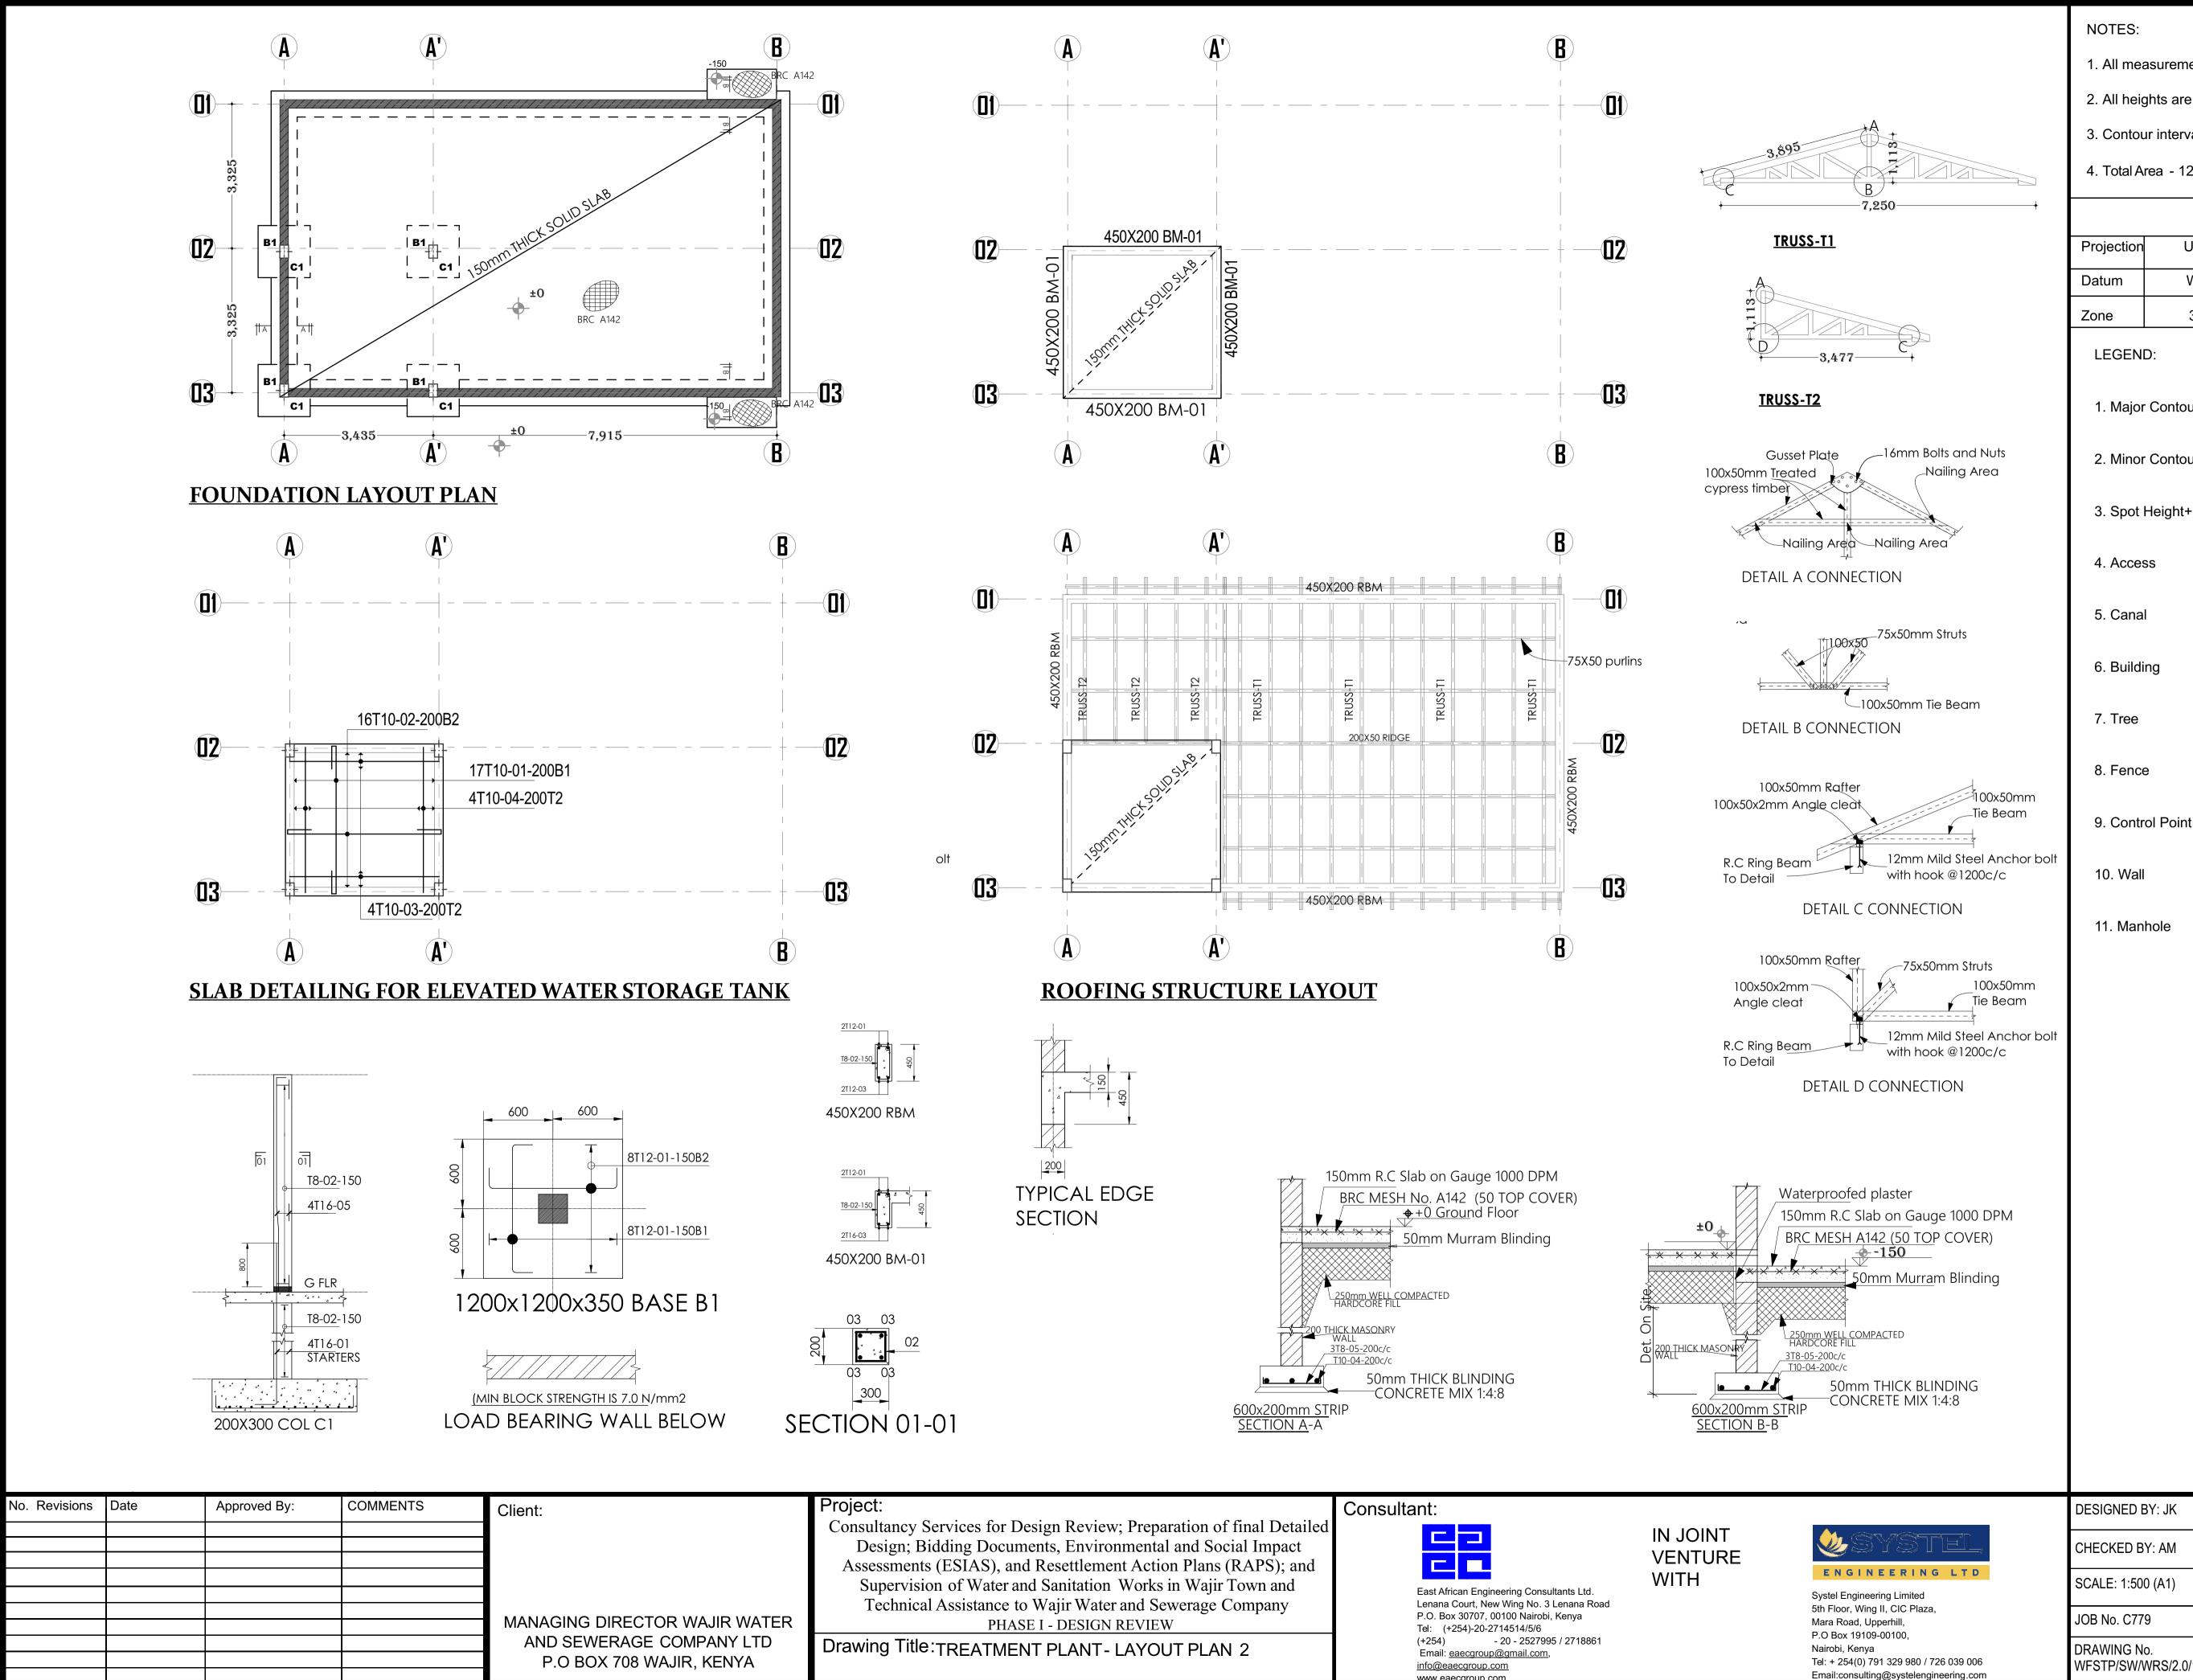

### DRAWN BY: SK DESIGNED BY: JK APPROVED BY: DNS CHECKED BY: AM DATE: June2023 SCALE: 1:500 (A1) JOB No. C779 SHEET 1 OF 1 A B C D E F G H I J K L DRAWING No. WFSTP/SW/WRS/2.0/1

### NOTES:

- 1. All measurements are in metres.
- 2. All heights are orthometric.
- 3. Contour interval is 0.25m


4. Total Area - 12.291ha (30.372acres) approx.

4. Iotal A	rea - 12.291h	a (30.37)	2acres) app
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Projection	UTM		
Datum	WGS 8	4	
Zone	37° NC	ORTH	
LEGENI	D:		
1. Major	Contour		
2. Minor	Contour		
3. Spot	Height+ Value	•219 <sup>,31</sup>	5
4. Acces	SS		
5. Cana	l ·		
6. Buildi	ng		
7. Tree		ET.)	


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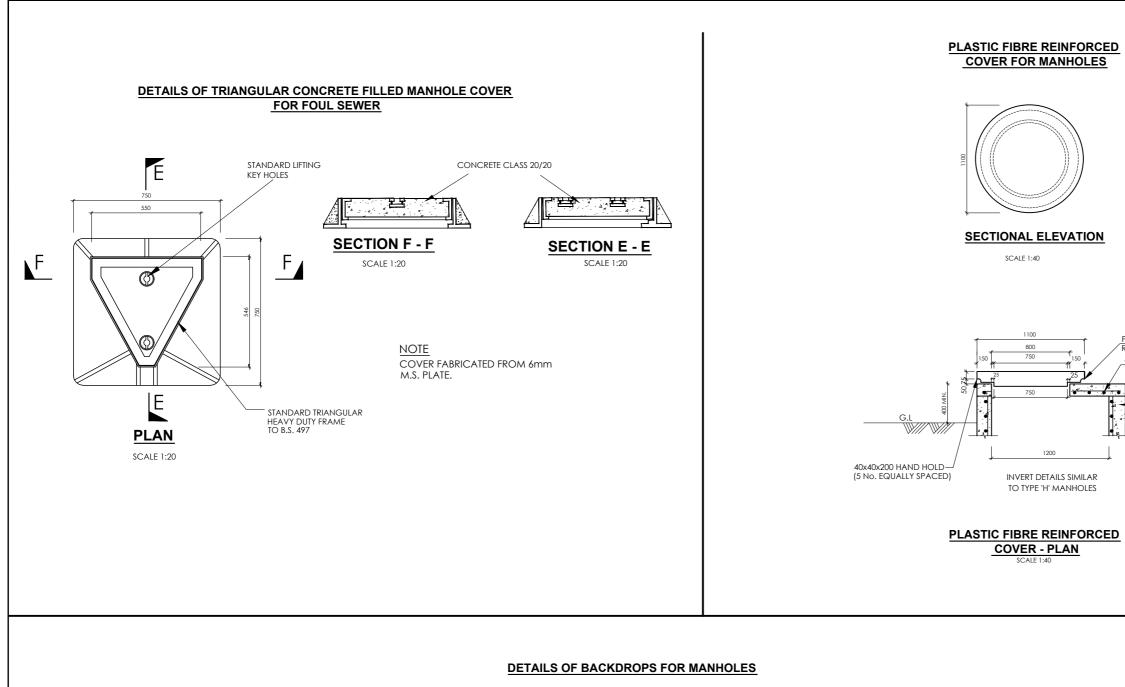
		Window So	chedule	
Elem	ent ID	WD - 002	WD - 003	WD - 003
Oper	ning Name	Vertical Multi-Sash	Vertical Multi-Sash	Vertical Multi-Sash
Quar	ntity	2	2	12
W x	H Size	1,000×1,000	1,400×1,000	900×1,000
Sill h	neight	1.400	1.400	1.400
Head	l height	2.400	2.400	2.400
2D S	ymbol			
3D B	ack View			
		Door Sch	edule	
Oper	ning Name	Door 25	Door 25	Door with Transom 25
Quar	ntity	2	10	2
Wx	H Size	900×2,100	800×2,100	1,000×2,400
Неас	l height	2.100	2.100	2.400
2D S	ymbol			
int:	Documents, En WALVASCO and	n Review; Preparation of final Detailed Desig Social Impact Assessments (ESIAS), and Re rvision of Water and Sanitation Works in Wa	esettlement	IN JOINT VENTURE


		2. ALL CC 3. ALL PF TO BS 4. CONC VIBRA ACCC SPECIF 5. TOLER 6. ALL H/ CONC SPECIF	MENSIONS A WISE STATED ONCRETE TO RECAST CON 556 RETE FILLING TED AND CU ICATION CL ANCE ON C AUNCHES AR RETE AS INDI ICATION OV MADE GOO	CLASS CLASS IRED IN ITH THE A AUSES. VERALLS RE CLASS ICATED C /ER EXCA	SS 20/20 NITS 25/20 PPROPRI/ SIZE 3mm 15/40 DN THE VATION	ATE	
		n.e NC c/c - CI MIN - M G.L G mm - M m - MET EXT. DIA OD - OL ND - NC RC - REI T10 - TW NTS - NC	EXTERNAI JTSIDE DIAM MINAL DIAM NFORCED C VISTED BAR 1 DT TO SCALE ER LIN. METE	IG INTRE EL L DIAMET ETER METER CONCRETI Omm SIZI	E	ER	
	DES	IGNED BY:	AM	DRA	WN BY	': AM	
	CHE	CKED BY:	AM	APP	ROVE	O BY:	SCW
	SCA	LE: 1:500 (	A1)	DATE	E: June	2023	
		No. C779		SH	IEET 1 Revisi		
6 m	DRA WFS	WING No. TP/SW/W8	LDS/01		Revis a b G H	on c ₪ i j	E K

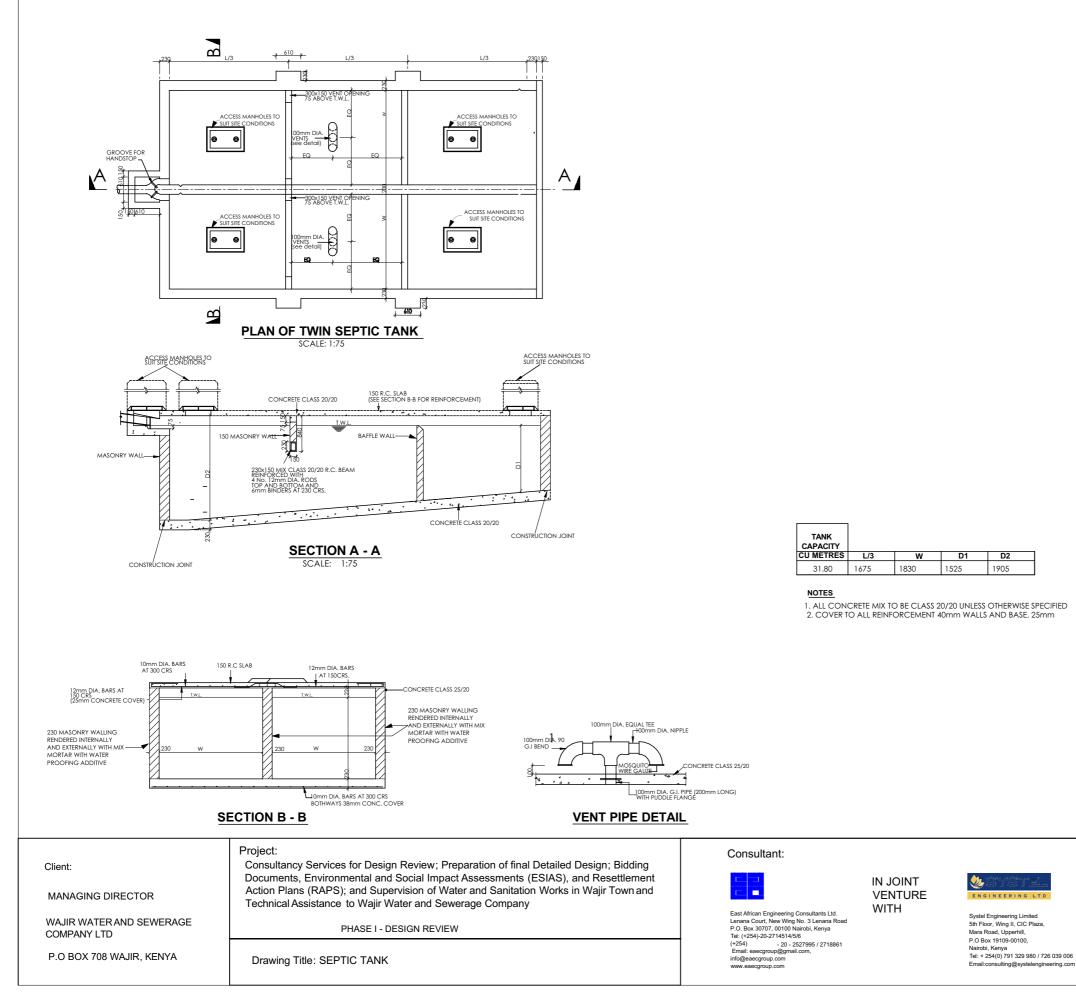


	NOTES 1. ALL DIMENSIONS J. OTHERWISS STATE 2. ALL CONCRETE T 3. ALL PRECAST CO TO BS 555 4. CONCRETE FILLIN VIBRATED AND C ACCORDANCE W SPECIFICATION C 5. TOLERANCE ON C 6. ALL HAUNCHS A CONCRETE AS IND SPECIFICATION O TO BE MADE GOC CLASS 15/40.	D BE CLASS 20/20 NCRETE UNITS G CLASS 25/20 URED IN HITH THE APPROPRIATE LAUSES. DVERALL SIZE 3mm RE CLASS 15/40 NICATED ON THE VER PCICAVATION
	ABBREVIAT n.e NOT EXCEED c/c - CENTRE TO C MIN - MINIMUM G.L GROUND LEY mm - MILIMETER m - MEIRE EXT. DIA - EXTERNA OD - OUTSIDE DIAM ND - NOMINAL DIA RC - REINFORCED C TIO - WISTED BAR NTS - NOT TO SCAL CU.M PER LIN. MET CL - CAST IRON	NG ENTRE LDIAMETER HETER WETER DONCRETE JONCRETE
	DESIGNED BY: AM	DRAWN BY: AM
	CHECKED BY: AM	APPROVED BY: SCW
	SCALE: 1:500 (A1)	DATE: June2023
	JOB No. C779	SHEET 1 OF 1
6	DRAWING No. WFSTP/SW/WRS/1.0/5	
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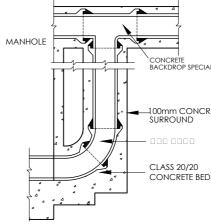




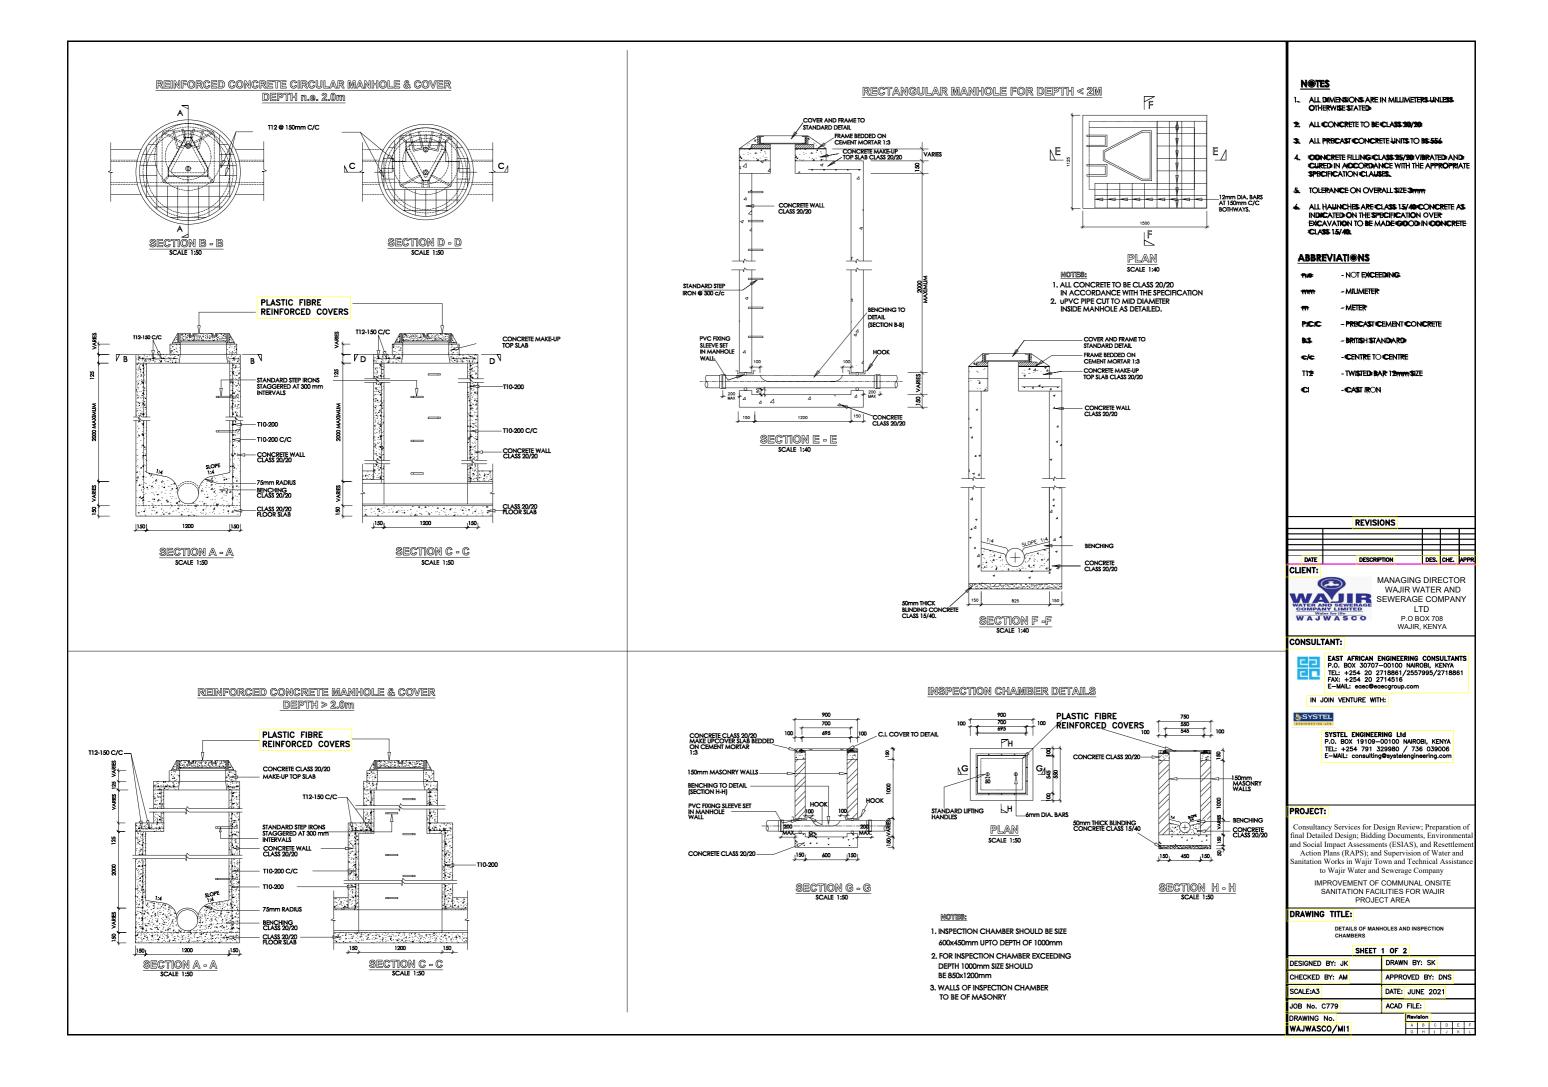

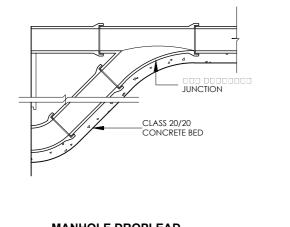



SCALE 1:20

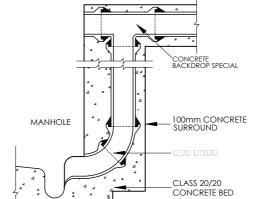

END ENTRANCE BACKDROP SCALE 1:20

	T	
	<u>NOTES</u>	
	1. ALL DIMENSIONS ARE OTHERWISE STATED	IN MILLIMETERS UNLESS
	2 ALL CONCRETE TO BE	CLASS 20/20
		ETE UNITS TO BS 554
	4. CONCRETE FILLING C	LASS 25/20 VIBRATED AND NCE WITH THE APPROPRIATE
	SPECIFICATION CLAU	SES.
	5. TOLERANCE ON OVE	
	INDICATED ON THE SP	CLASS 15/40 CONCRETE AS BCIFICATION OVER MADE GOOD IN CONCRETE
	ABBREVIATIONS	
	+ - NOT EXCE	EDING
	++++++++++++++++++++++++++++++++++++++	:
	-METER	
	PICIC -PRECAST	CEMENT CONCRETE
	BLS BRITISH ST/	NDARD
	C/C -CENTRE TO	CENTRE
<u>ASTI</u> C FIBRE		AR 12mmSIZE
	CI -CAST IRON	4
2 @ 150mm C/C		
3		
CONCRETE WALLING CLASS 20/20		
G.L		
V/// V///		
	REVIS	
	REVIJ	
	DATE DESCRI	PTION DES. CHE. APPR
	CLIENT:	
		MANAGING DIRECTOR WAJIR WATER AND
	COMPANY LIMITED	SEWERAGE COMPANY LTD
	Water for life WAJWASCO	P.O BOX 708 WAJIR, KENYA
	CONSULTANT:	
	EAST AFRICAN	ENGINEERING CONSULTANTS
	EAST AFRICAN P.O. BOX 30707 TEL: +254 20 2 FAX: +254 20 2	-00100 NAIROBI, KENYA 2718861/2557995/2718861 2714516
	EAST AFRICAN P.O. BOX 30707 TEL: +254 20 2 FAX: +254 20 2 E-MAIL: edec@e	-00100 NAIROBI, KENYA 2718861/2557995/2718861 2714516 aecgroup.com
	EAST AFRICAN P.O. BOX 30707 TEL: +254 20 2 FAX: +254 20 2 E-MAIL: ecce@e	-00100 NAIROBI, KENYA 2718861/2557995/2718861 2714516 aecgroup.com
	EAST AFRICAN P.O. BOX 30707 TEL: +254 20 J FAX: +254 20 J E-MAIL: eoec@c IN JOIN VENTURE WIT	-00100 NAIROBI, KENYA 2718861/2557995/2718861 2714516 secgroup.com
	EAST AFRICAN P.O. BOX 30707 TEL: +254 20 E-MAIL: ecec@e IN JOIN VENTURE WIT SYSTEL P.O. BOX 19109- TEL: +254 791 3	-00100 NAIROBI, KENYA 2718861/2557995/2718861 2714516 becgroup.com Ht: RING Ltd -00100 NAIROBI, KENYA 29980 / 736 039006
	EAST AFRICAN P.O. BOX 30707 TEL: +254 20 E-MAIL: ecec@e IN JOIN VENTURE WIT SYSTEL P.O. BOX 19109- TEL: +254 791 3	-00100 NAIROBI, KENYA 2718861/2557995/2718861 2714516 secgroup.com TH: RING Ltd -00100 NAIROBI, KENYA
	EAST AFRICAN P.O. BOX 30707 TEL: +254 20 E-MAIL: ecec@e IN JOIN VENTURE WIT SYSTEL P.O. BOX 19109- TEL: +254 791 3	-00100 NAIROBI, KENYA 2718861/2557995/2718861 2714516 becgroup.com Ht: RING Ltd -00100 NAIROBI, KENYA 29980 / 736 039006
	EAST AFRICAN P.O. BOX 30707 TEL: +254 20 E-MAIL: ecec@e IN JOIN VENTURE WIT SYSTEL P.O. BOX 19109- TEL: +254 791 3	-00100 NAIROBI, KENYA 2718861/2557995/2718861 2714516 becgroup.com Ht: RING Ltd -00100 NAIROBI, KENYA 29980 / 736 039006
	AST AFRICAN P.O. BOX 35707 EL: +254 20 2 FAX: +254	-00100 NAIROBI, KENYA 2718861/2557995/2718861 2714516 secgroup.com TH: RING Ltd -00100 NAIROBI, KENYA 329980 / 736 039006 g@eystelengineering.com
	AST AFRICAN     P.O. BOX 30701     EL: +254 20     FAX: +254 20     E-MAIL: ecocOe     IN JOIN VENTURE WI     SYSTEL ENGINEE     P.O. BOX 19109-     TEL: +254 791 3     E-MAIL: consultan      PROJECT:     Consultancy Services for D     fnal Detailed Design; Biddi	-00100 NAIROBI, KENYA 2718861/2557995/2718861 2714516 secgroup.com TH: RING Ltd -00100 NAIROBI, KENYA 529980 / 736 039006 g@systelengineering.com
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	AST AFRICAN     P.O. BOX 35707     EL: +254 20     TEL: +254 20     E-Mall: ecocode     IN JOIN VENTURE WI     SYSTEL     P.O. BOX 19109-     TEL: +254 791     E-MALL: consultin      PROJECT:     Consultancy Services for D     final Detailed Design; Biddi     and Social Impact Assessme     Action Plans (RAPS); an     Sanitation Works in Wajir T	-00100 NAIROBI, KENYA 2718861/2557955/2718861 2714516 becgroup.com Ht: RING Ltd -00100 NAIROBI, KENYA 259980 / 736 039006 g@eystelengineering.com
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	PROJECT:         Consultancy Services for D         Final Detailed Design; Biddi         and Social Impact Assessme         Action Plans (RAPS); and Sanitation Works in Wajir T         to Wajir Water and IMPROVEMENT OF SANITATION FAC         PROJECT:         Drawing Title:	-00100 NAROBI, KENYA 2718861/2557955/2718861 2714516 secgroup.com TH: RING Ltd -00100 NAROBI, KENYA 529980 / 736 039006 g@systelengineering.com g@systelengineering.com the SUpervision of Water and own and Technical Assistance I Sewerage Company COMMUNAL ONSITE 21LITIES FOR WAJIR CT AREA
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	AST AFRICAN     P.O. BOX 3707     EL: +254 20     E-MAIL: eccedee     IN JOIN VENTURE WI      SYSTEL     SYSTEL ENGINEE     P.O. BOX 19105     TEL: +254 791     TEL: +25	-00100 NAROBI, KENYA 2718861/2557955/2718861 2714516 secgroup.com TH: RING Ltd -00100 NAROBI, KENYA 529980 / 736 039006 g@systelengineering.com g@systelengineering.com the SUpervision of Water and own and Technical Assistance I Sewerage Company COMMUNAL ONSITE 21LITIES FOR WAJIR CT AREA
	AST AFRICAN     P.O. BOX 3707     EL: +254 20     E-MAIL: eccedee     IN JOIN VENTURE WI      SYSTEL     SYSTEL ENGINEE     P.O. BOX 19109-     TEL: +254 791     TEL: +2	-00100 NAIROBI, KENYA 2718861/2557955/2718861 2714516 secgroup.com HI: RING Ltd -00100 NAIROBI, KENYA 529980 / 736 039006 g@eystelengineering.com esign Review; Preparation of ng Documents, Environmental nts (ESIAS), and Resettlement d Supervision of Water and own and Technical Assistance I Sewerage Company : COMMUNAL ONSITE 3/LITIES FOR WAJIR :CT AREA HOLES AND INSPECTION 2 OF 2 DRAWN BY: SK
	AST AFRICAN     P.O. BOX 35707     EL: +254 20     F.X. +254 20     F	-00100 NAIROBI, KENYA 2718861/2557955/2718861 2714516 secgroup.com HI: RING Ltd -00100 NAIROBI, KENYA 529980 / 736 039006 g@eystelengineering.com esign Review; Preparation of g@eystelengineering.com esign Review; Preparation of g@eystelengineering.com context in the second second second g@eystelengineering.com context in the second seco
	AST AFRICAN     P.O. BOX 3707     EL: +254 20     E-MAIL: eccedee     IN JOIN VENTURE WI      SYSTEL     SYSTEL ENGINEE     P.O. BOX 19109-     TEL: +254 791     TEL: +2	-00100 NAIROBI, KENYA 2718861/2557955/2718861 2714516 secgroup.com HI: RING Ltd -00100 NAIROBI, KENYA 529980 / 736 039006 g@eystelengineering.com esign Review; Preparation of ng Documents, Environmental nts (ESIAS), and Resettlement d Supervision of Water and own and Technical Assistance I Sewerage Company : COMMUNAL ONSITE 3/LITIES FOR WAJIR :CT AREA HOLES AND INSPECTION 2 OF 2 DRAWN BY: SK

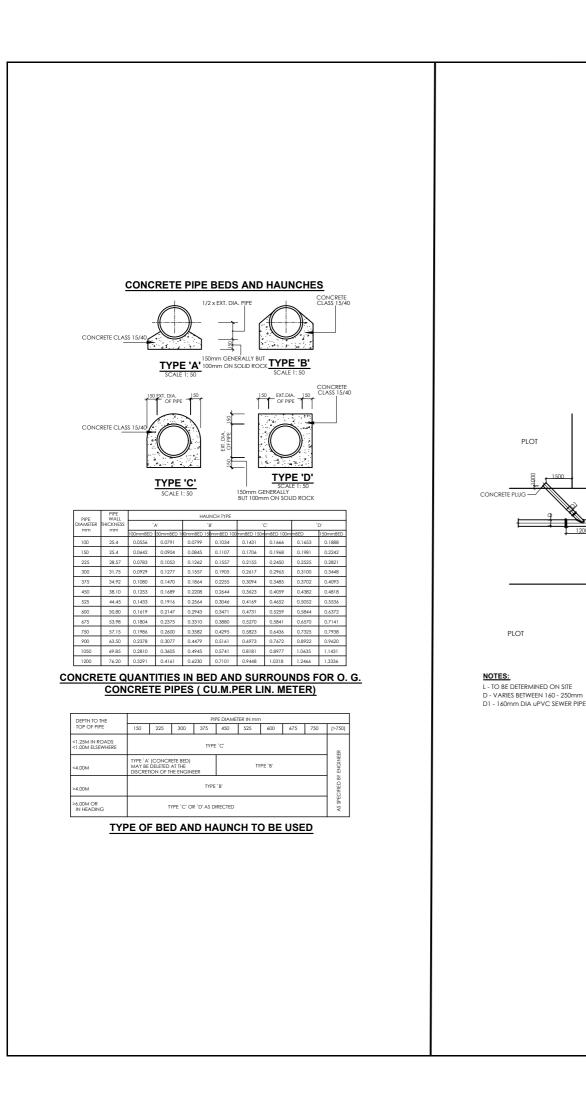

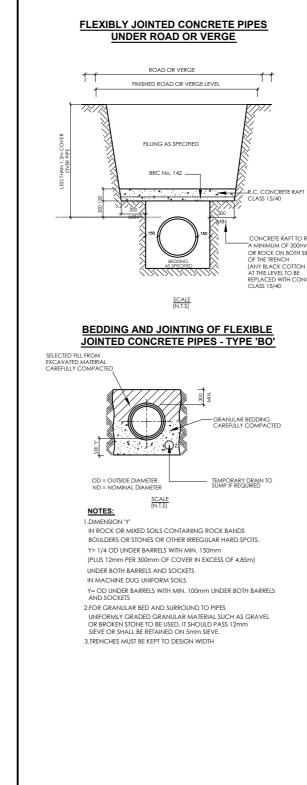

**Y - JUNCTION DETAILS** 

PLOT BOUNDARY

ROAD RESERVE / WAYLEAVE

SCALE (N.T.S)

-PLOT BOUNDARY

PLOT

PLOT

PLOT BOUNDARY

-PLOT BOUNDARY

PLOT

PLOT

### <u>NOTES</u>

- . All dimensions are in millimeters unless otherwise stated ٦.
- 2. ALL CONCRETE TO BE CLASS 20/20
- 3. ALL PRECAST CONCRETE UNITS TO BESSE
- 4. CONCRETE FILING CLASS 25/20 VIBRATED AND CURED IN ACCORDANCE WITH THE APPROPRIATE SPECIFICATION CLAUSES.
- 5. TOLERANCE ON OVERALL SIZE 3mm
- ALL HAUNCHES ARE CLASS 15/40:00NCRETE AS INDICATED ON THE SPECIFICATION OVER ENCAVATION TO BE MADE GOOD IN CONCRETE CLASS 15/40.

ABBREVIATIONS				
-	- NOT EXICEEDING			
c/c	-CENTRE TO CENTRE			
MIN	-MINIMUM			
GL	- GROUND LEVEL			
-	- MILIMETER			
Ħ	-METER			
EXT. DIA	-EXTERNAL DIAMETER			
0.0	-OUTSIDE DIAMETER			
ND	- NOMINAL DIAMETER			
RC:	-REINFORCEDICONCRETE			
TI	- TWISTED BAR 10mm SIZE			
NTS	-NOT TO SCALE			
THK	- TH <b>HCK</b>			
JPVC:	-UNPLASTICISED POLYVINYL CHLORIDE			
Nos.	- NUMBERS			
CUM PER	LIN. METER - CUBIC METER PER LINEAR METER			

CONCRETE RAFT TO REST ON A MINIMUM OF 300mm MURRAM OR ROCK CON BOTH SIDES OF THE TRENCH (ANY BLACK COTTON SOIL) AT THIS LEVEL TO BE REPLACED WITH CONCRETE CLASS 15/40

		REVISI	ONS				
DATE		DESCRI	TION		DES.	CHE.	APPR
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CONSULT	ANT:			., 1011 (,			
	P.O. BC TEL: +2 FAX: +2	FRICAN I 0X 30707 254 20 2 254 20 2 eaec@ea	-00100 718861 714516	NAIRO /2557	ЭВІ, К	ENYA	
IN JO	oin ven	TURE WIT	H:				
&SYST	EL						
	E-MAIL:	consultin	gøsyste	lengine	ering.	com	
PROJECT	:						
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